
## APPENDIX 7: LANDSCAPE MASTER PLAN

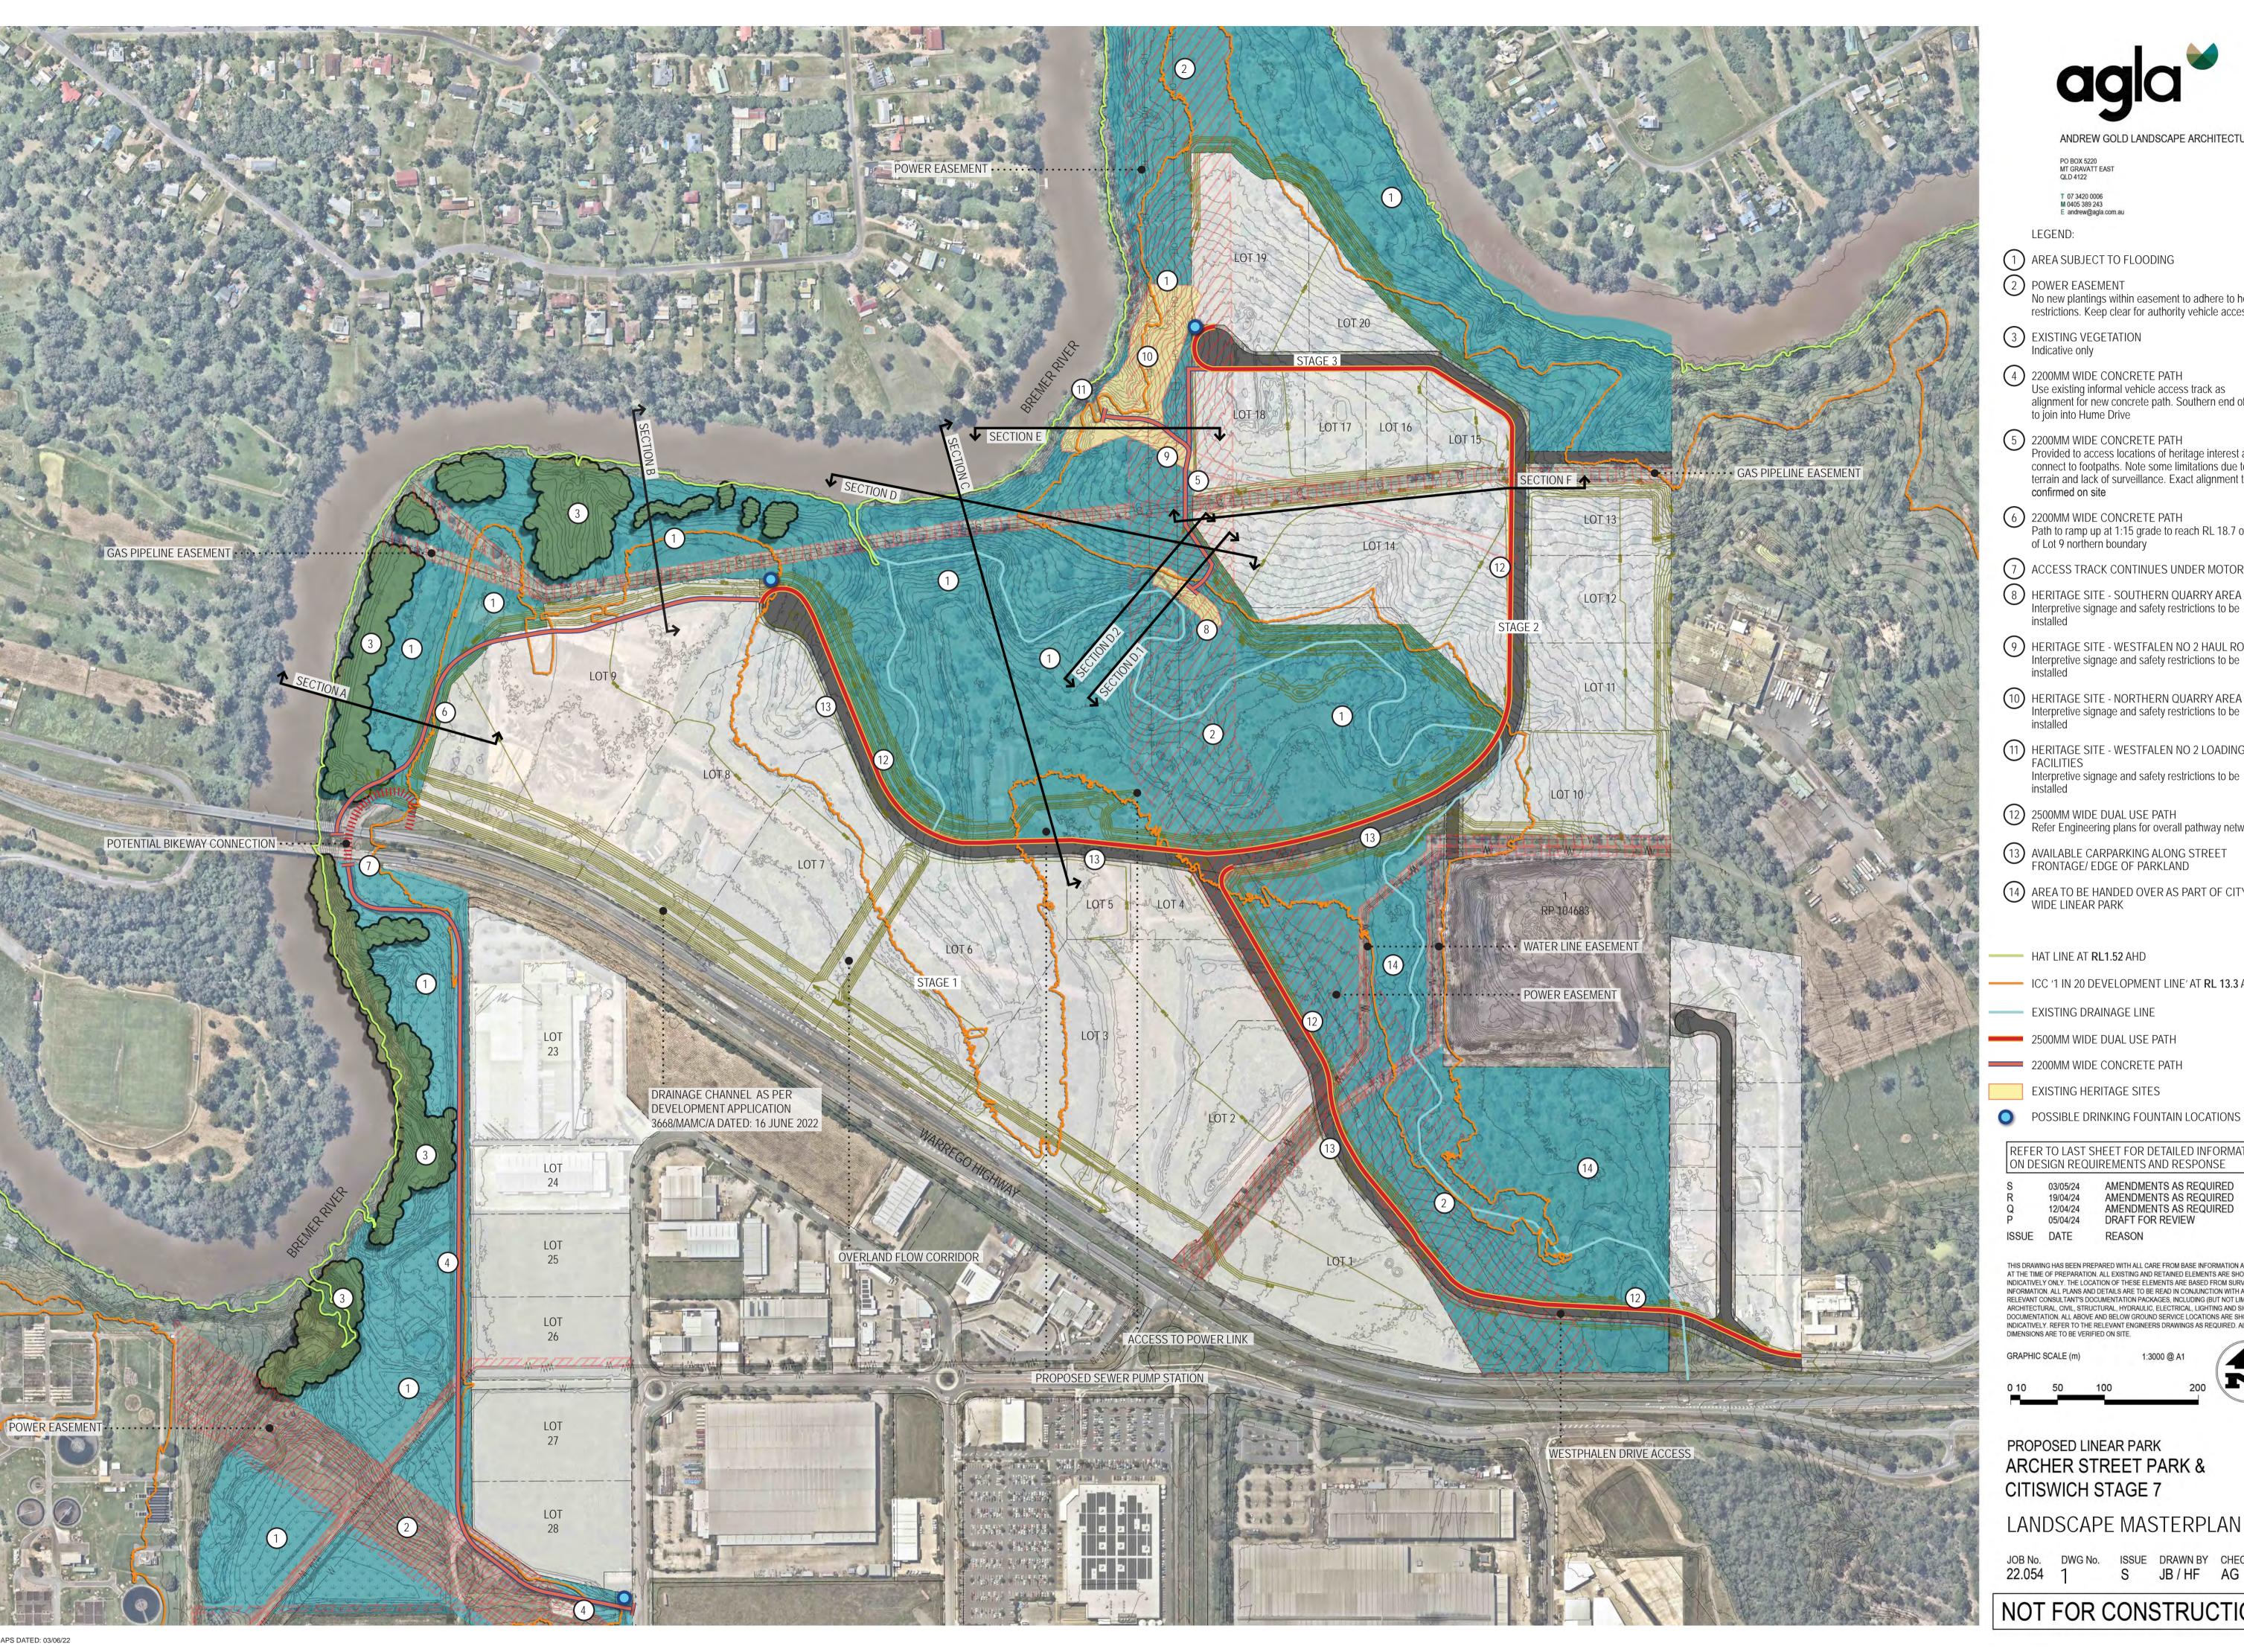



PO BOX 5220 MT GRAVATT EAST QLD 4122

M 0405 389 243 E andrew@agla.com.au

1) AREA SUBJECT TO FLOODING

2 POWER EASEMENT No new plantings within easement to adhere to height restrictions. Keep clear for authority vehicle access.

3 EXISTING VEGETATION Indicative only

2200MM WIDE CONCRETE PATH
Use existing informal vehicle access track as alignment for new concrete path. Southern end of path to join into Hume Drive

2200MM WIDE CONCRETE PATH
Provided to access locations of heritage interest and
connect to footpaths. Note some limitations due to
terrain and lack of surveillance. Exact alignment to be confirmed on site

2200MM WIDE CONCRETE PATH
Path to ramp up at 1:15 grade to reach RL 18.7 on top
of Lot 9 northern boundary

7 ACCESS TRACK CONTINUES UNDER MOTORWAY

8 HERITAGE SITE - SOUTHERN QUARRY AREA Interpretive signage and safety restrictions to be installed

9 HERITAGE SITE - WESTFALEN NO 2 HAUL ROAD Interpretive signage and safety restrictions to be installed

HERITAGE SITE - NORTHERN QUARRY AREA Interpretive signage and safety restrictions to be installed

11) HERITAGE SITE - WESTFALEN NO 2 LOADING FACILITIES Interpretive signage and safety restrictions to be installed

2500MM WIDE DUAL USE PATH
Refer Engineering plans for overall pathway network

13) AVAILABLE CARPARKING ALONG STREET FRONTAGE/ EDGE OF PARKLAND

AREA TO BE HANDED OVER AS PART OF CITY WIDE LINEAR PARK

— HAT LINE AT RL1.52 AHD

ICC '1 IN 20 DEVELOPMENT LINE' AT **RL 13.3** AHD

2500MM WIDE DUAL USE PATH

2200MM WIDE CONCRETE PATH

EXISTING HERITAGE SITES

REFER TO LAST SHEET FOR DETAILED INFORMATION ON DESIGN REQUIREMENTS AND RESPONSE

AMENDMENTS AS REQUIRED AMENDMENTS AS REQUIRED AMENDMENTS AS REQUIRED DRAFT FOR REVIEW 05/04/24

THIS DRAWING HAS BEEN PREPARED WITH ALL CARE FROM BASE INFORMATION AVAILABLE AT THE TIME OF PREPARATION. ALL EXISTING AND RETAINED ELEMENTS ARE SHOWN INDICATIVELY ONLY. THE LOCATION OF THESE ELEMENTS ARE BASED FROM SURVEY INFORMATION. ALL PLANS AND DETAILS ARE TO BE READ IN CONJUNCTION WITH ALL RELEVANT CONSULTANT'S DOCUMENTATION PACKAGES, INCLUDING (BUT NOT LIMITED TO) ARCHITECTURAL, CIVIL, STRUCTURAL, HYDRAULIC, ELECTRICAL, LIGHTING AND SIGNAGE DOCUMENTATION. ALL ABOVE AND BELOW GROUND SERVICE LOCATIONS ARE SHOWN INDICATIVELY. REFER TO THE RELEVANT ENGINEERS DRAWINGS AS REQUIRED. ALL DIMENSIONS ARE TO BE VERIFIED ON SITE.

PROPOSED LINEAR PARK ARCHER STREET PARK &

LANDSCAPE MASTERPLAN

ISSUE DRAWN BY CHECKED BY JB / HF AG

LEGEND	COUNCIL REQUIREMENTS	DESIGN PROPOSAL
8 9 10 11	Identify places/ locations or structures through appropriately located and detailed interpretive signage describing the history and cultural significance of relevant items  Item 8 on Conditions attachment A	Install interpretive signage and any appropriate safety measurements to identify north and south quarry areas, the Westfalen no 2 loading facilities and Westfalen no 2 haul road
3	Dead trees shall be removed, and dangerous trees made safe within 10m of proposed house blocks, or proposed pathways or playgrounds  Item 25a) on Conditions attachment A	Arborist to review trees within subject area and remove and/or prune (make safe) any trees considered to pose a threat  Where trees may be deemed unsafe and require felling it may be appropriate to drop and leave in place (or within corridor) to create habitat opportunities
1	Disturbed areas shall be revegetated using indigenous plant species  Item 25e) on Conditions attachment A	Allow natural vegetation with appropriate weed management to reduce ongoing maintenance burden.  Where parts of the site have been disturbed due to construction works then those areas should be trimmed, graded and topsoiled (if required). Revegetation to be implemented in accordance with flood report and vegetation management plans.
4 5 9	A linear park should be min 15m in width and capable of accommodating walking/ cycling path and maintenance access (preferably vehicular) with a constructed concrete pathway 2200mm wide for the length of the park (preferably adjacent to creek) integrated with pedestrian/ cycle network  Page 60 Local Government Infrastructure Plan Supporting Document Public Parks Update 2016	The linear park is well over min 15m in width (min 30m) in all locations but given the varying degrees of unevenness of the terrain and isolated nature of much of the length of the linear park it would be hazardous to propose a shared path along the available length Alternative Proposal:  Include a 2200mm wide path in select locations with either suitable surveillance or which lead to a feature of interest such as a historic site or natural element. The path should be constructed from materials that consider the effects of flooding
8 9 10 11	Linear park works to include identity, directional and interpretive signage  Page 60 Local Government Infrastructure Plan Supporting Document Public Parks Update 2016	Interpretive signage to be included at relevant locations in accordance with the Cultural Heritage Management Plan December 2008
13)	Street parking along park frontage  Page 60 Local Government Infrastructure Plan Supporting Document Public Parks Update 2016	All road frontages to have street parking on 3m wide shoulders on both sides of industrial roads.
1 3	Achieve fully vegetated corridor using endemic species with density of 3 plants per m2  Page 60 Local Government Infrastructure Plan Supporting Document Public Parks Update 2016	Revegetation to be implemented in accordance with flood report and vegetation management plans.
GENERAL	Declared plants, environmental weeds and rubbish shall be removed  Item 25 on Conditions attachment A	Undertake appropriate clearing and weeding eradiation/ management of Council identified weeds within the site either through mass clearing or targeted treatment
GENERAL	The linear park should include 1 x drinking fountain (disabled compliant) adjacent the pathway every 2kms, 1 park table and bench seats every hectarre, 2x bench seat adjacent pathway every hectare  Page 60 Local Government Infrastructure Plan Supporting Document Public Parks Update 2016	3 drinking fountains can be provided at the following accessible locations: at the end of the northern, at the western cul-de-sac (Lot 9), and at the linear park entrance along Hume Drive.



PO BOX 5220 MT GRAVATT EAST QLD 4122

T 07 3420 0006 M 0405 389 243 € andrew@agla.com.au

S 03/05/24 AMENDMENTS AS REQUIRED
R 19/04/24 AMENDMENTS AS REQUIRED
Q 12/04/24 AMENDMENTS AS REQUIRED
P 05/04/24 DRAFT FOR REVIEW

ISSUE DATE REASON


THIS DRAWING HAS BEEN PREPARED WITH ALL CARE FROM BASE INFORMATION AVAILABLE AT THE TIME OF PREPARATION. ALL EXISTING AND RETAINED ELEMENTS ARE SHOWN INDICATIVELY ONLY. THE LOCATION OF THESE ELEMENTS ARE BASED FROM SURVEY INFORMATION. ALL PLANS AND DETAILS ARE TO BE READ IN CONJUNCTION WITH ALL RELEVANT CONSULTANT'S DOCUMENTATION PACKAGES, INCLUDING (BUT NOT LIMITED TO) ARCHITECTURAL, CIVIL, STRUCTURAL, HYDRAULIC, ELECTRICAL, LIGHTING AND SIGNAGE DOCUMENTATION. ALL ABOVE AND BELOW GROUND SERVICE LOCATIONS ARE SHOWN INDICATIVELY. REFER TO THE RELEVANT ENGINEERS DRAWINGS AS REQUIRED. ALL DIMENSIONS ARE TO BE VERIFIED ON SITE.

PROPOSED LINEAR PARK ARCHER STREET PARK & CITISWICH STAGE 7

DESIGN REQUIREMENTS

JOB No. DWG No. ISSUE DRAWN BY CHECKED BY 22.054 2 S JB / HF AG

## SECTION - A HORIZONTAL SCALE 1:400 @ A1 VERTICAL SCALE 1:400 @ A1

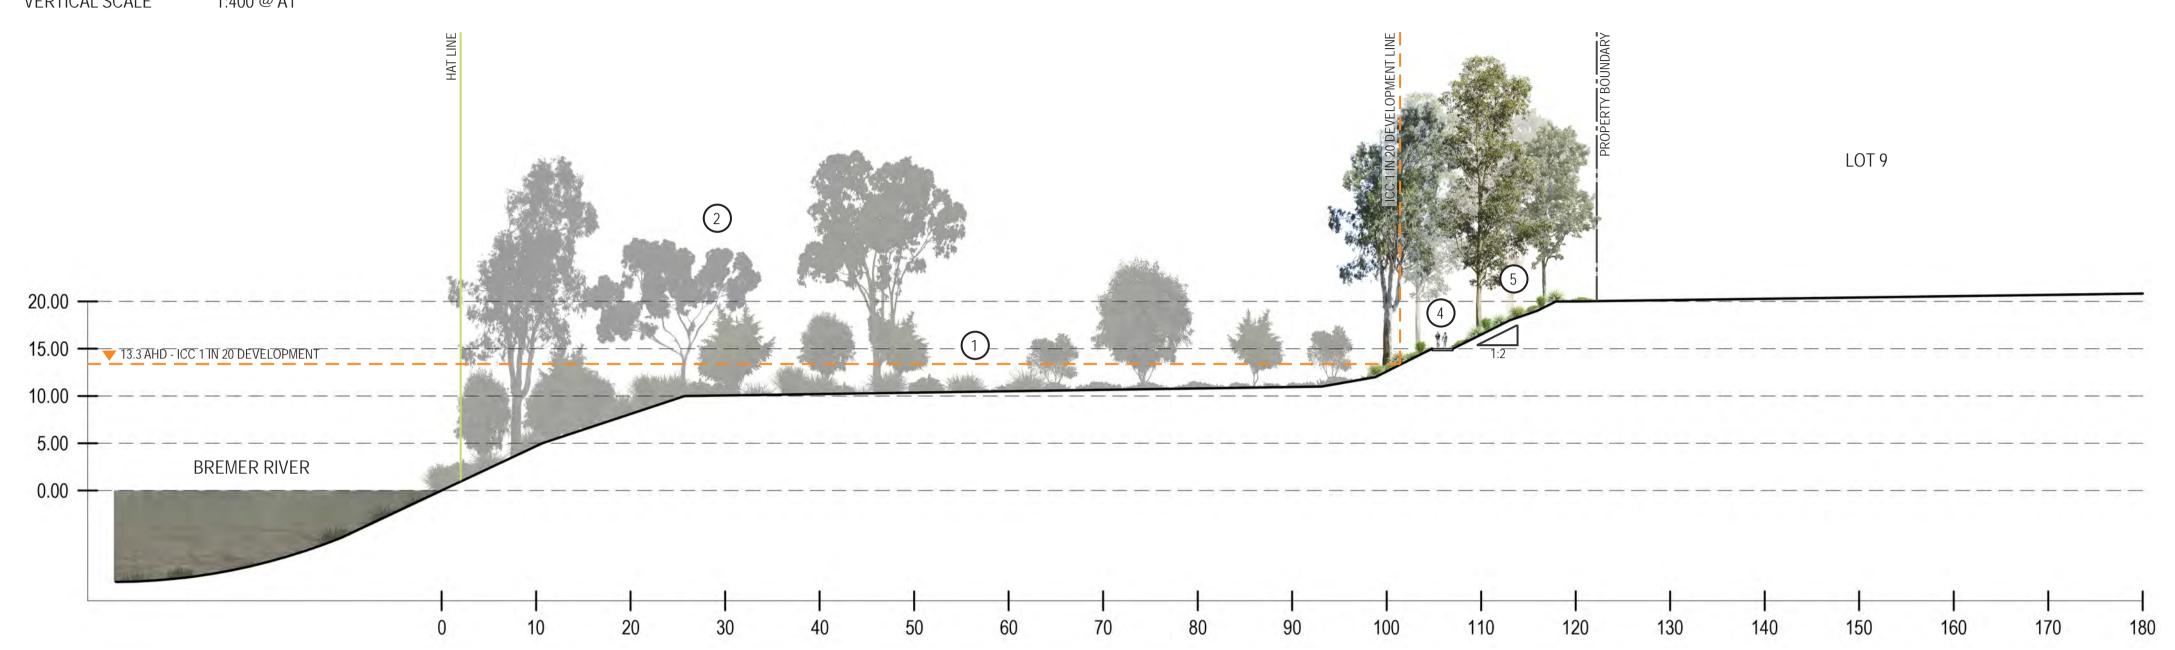







ANDREW GOLD LANDSCAPE ARCHITECTURE

PO BOX 5220 MT GRAVATT EAST QLD 4122

T 07 3420 0006 M 0405 389 243 € andrew@agla.com.au

LEGEND:

- 1 AREA SUBJECT TO FLOODING
- 2 EXISTING VEGETATION Indicative only
- 2200MM WIDE CONCRETE PATH
  Provided to access locations of heritage interest and
  connect to footpaths. Note some limitations due to
  terrain and lack of surveillance. Exact alignment to be
  confirmed on site
- 2200MM WIDE CONCRETE PATH
  Path to ramp up at 1:15 grade to reach RL 18.7 on top
  of Lot 9 northern boundary
- PROPOSED PARK REVEGETATION
  Species to be in accordance with Ipswich City Council standards, to future detail. Refer Engineering drawings for proposed earthworks.

HAT LINE AT RL1.52 AHD

--- ICC '1 IN 20 DEVELOPMENT LINE' AT RL 13.3 AHD

03/05/24 AMENDMENTS AS REQUIRED 19/04/24 AMENDMENTS AS REQUIRED 12/04/24 AMENDMENTS AS REQUIRED 05/04/24 DRAFT FOR REVIEW

P 05/04/24 DRAF ISSUE DATE REAS

THIS DRAWING HAS BEEN PREPARED WITH ALL CARE FROM BASE INFORMATION AVAILABLE AT THE TIME OF PREPARATION. ALL EXISTING AND RETAINED ELEMENTS ARE SHOWN INDICATIVELY ONLY. THE LOCATION OF THESE ELEMENTS ARE BASED FROM SURVEY INFORMATION. ALL PLANS AND DETAILS ARE TO BE READ IN CONJUNCTION WITH ALL RELEVANT CONSULTANT'S DOCUMENTATION PACKAGES, INCLUDING (BUT NOT LIMITED TO) ARCHITECTURAL, CIVIL, STRUCTURAL, HYDRAULIC, ELECTRICAL, LIGHTING AND SIGNAGE DOCUMENTATION. ALL ABOVE AND BELOW GROUND SERVICE LOCATIONS ARE SHOWN INDICATIVELY. REFER TO THE RELEVANT ENGINEERS DRAWINGS AS REQUIRED. ALL DIMENSIONS ARE TO BE VERIFIED ON SITE.

GRAPHIC SCALE (m) 1:400@A1

0 2 4 6 8 10

PROPOSED LINEAR PARK
ARCHER STREET PARK &
CITISWICH STAGE 7


PROPOSED LANDSCAPE SECTIONS


JOB No. DWG No. ISSUE DRAWN BY CHECKED BY 22.054 3 S JB / HF AG

SECTION - C

HORIZONTAL SCALE 1:400 @ A1

VERTICAL SCALE 1:400 @ A1

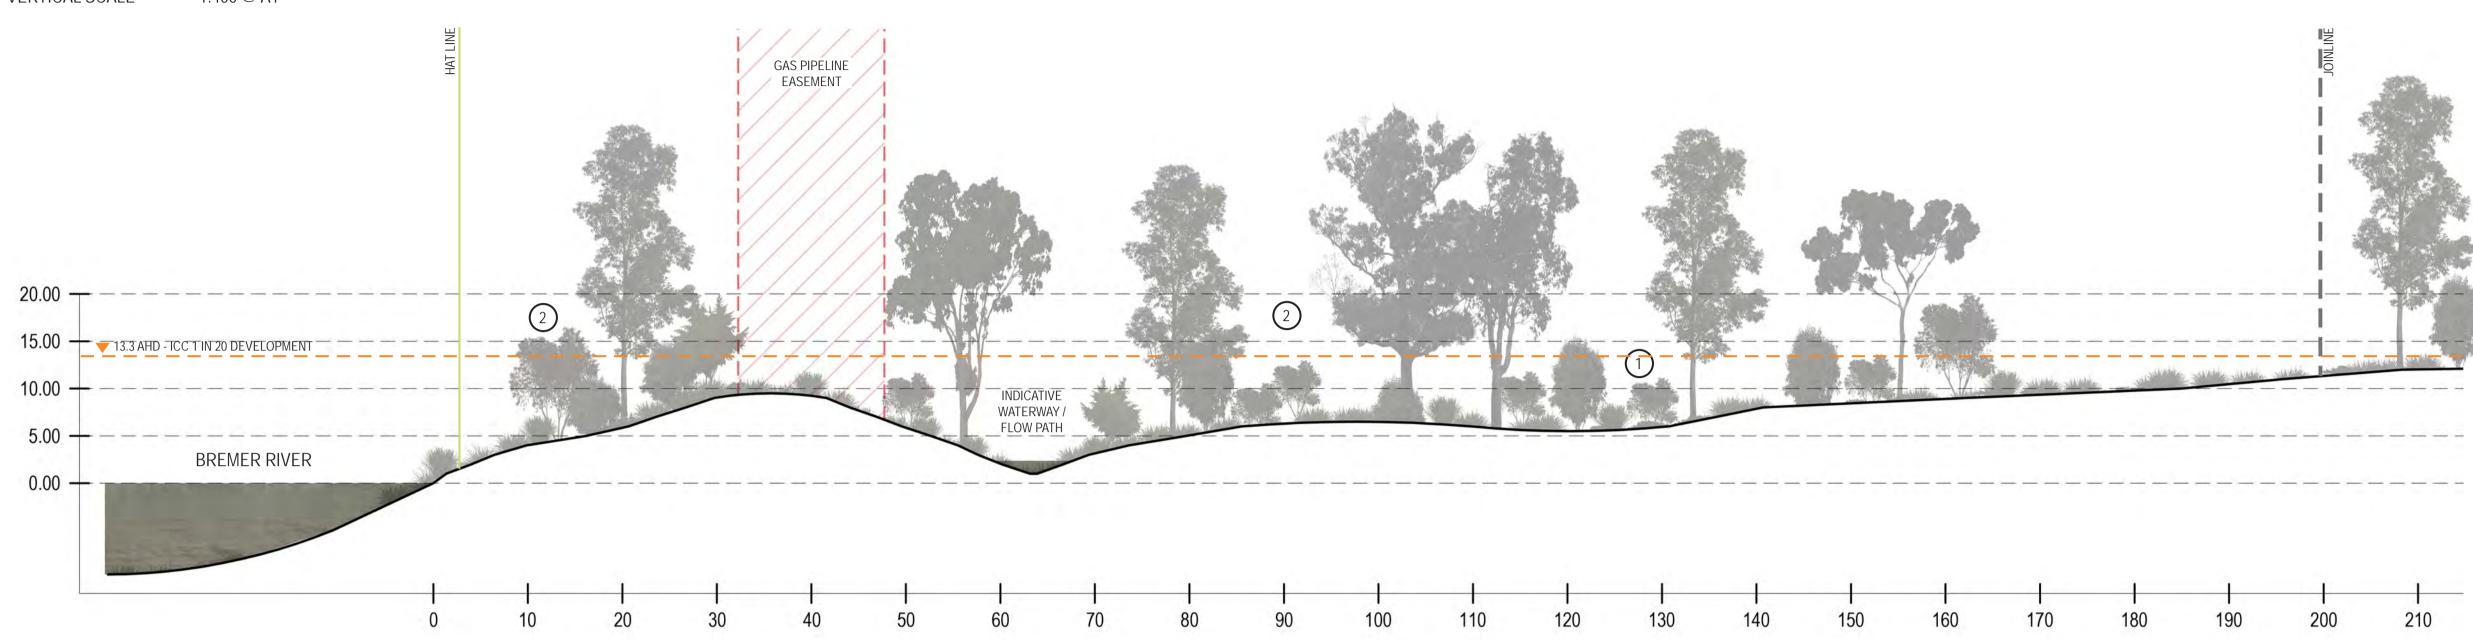

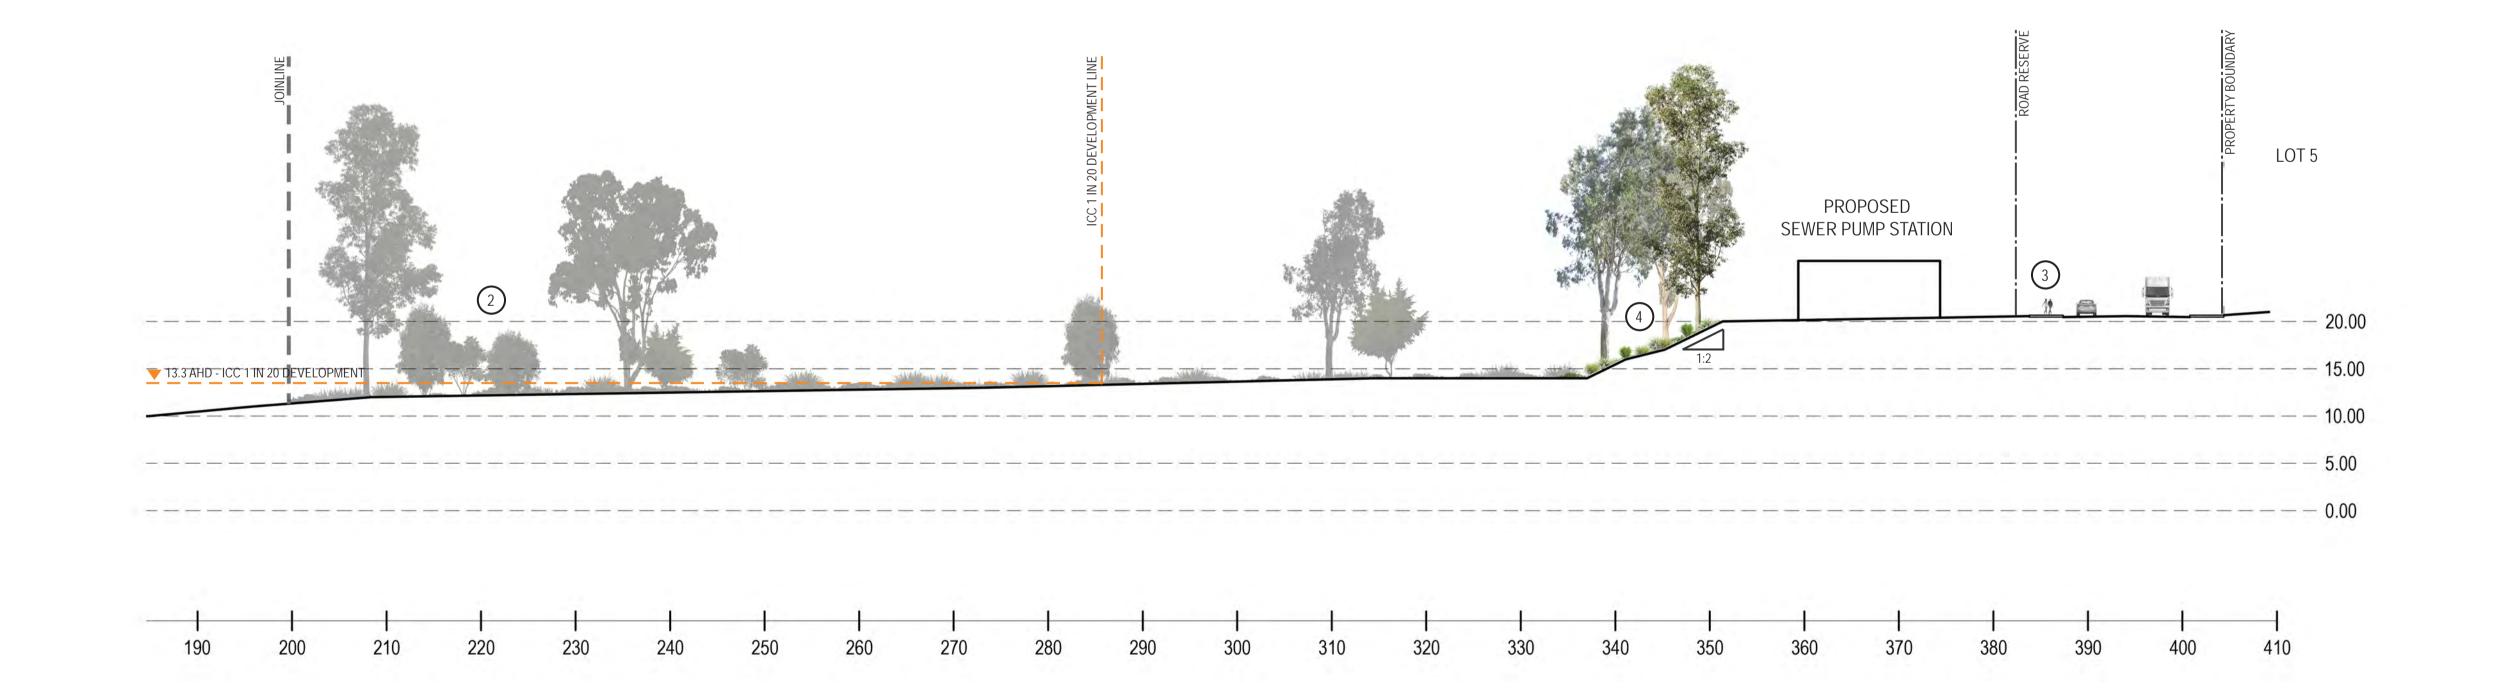



PO BOX 5220 MT GRAVATT EAST QLD 4122

T 07 3420 0006 M 0405 389 243 € andrew@agla.com.au

LEGEND:

AREA SUBJECT TO

1 AREA SUBJECT TO FLOODING
2 EXISTING VEGETATION Indicative only

2500MM WIDE DUAL USE PATH
Refer Engineering plans for overall pathway network

PROPOSED PARK REVEGETATION
Species to be in accordance with Ipswich City Council standards, to future detail. Refer Engineering drawings for proposed earthworks.

HAT LINE AT RL1.52 AHD

--- ICC '1 IN 20 DEVELOPMENT LINE' AT RL 13.3 AHD

S 03/05/24 AMENDMENTS AS REQUIRED R 19/04/24 AMENDMENTS AS REQUIRED Q 12/04/24 AMENDMENTS AS REQUIRED DRAFT FOR REVIEW

P 05/04/24 DR ISSUE DATE RE

THIS DRAWING HAS BEEN PREPARED WITH ALL CARE FROM BASE INFORMATION AVAILABLE AT THE TIME OF PREPARATION. ALL EXISTING AND RETAINED ELEMENTS ARE SHOWN INDICATIVELY ONLY. THE LOCATION OF THESE ELEMENTS ARE BASED FROM SURVEY INFORMATION. ALL PLANS AND DETAILS ARE TO BE READ IN CONJUNCTION WITH ALL RELEVANT CONSULTANT'S DOCUMENTATION PACKAGES, INCLUDING (BUT NOT LIMITED TO) ARCHITECTURAL, CIVIL, STRUCTURAL, HYDRAULIC, ELECTRICAL, LIGHTING AND SIGNAGE DOCUMENTATION. ALL ABOVE AND BELOW GROUND SERVICE LOCATIONS ARE SHOWN INDICATIVELY. REFER TO THE RELEVANT ENGINEERS DRAWINGS AS REQUIRED. ALL DIMENSIONS ARE TO BE VERIFIED ON SITE.


GRAPHIC SCALE (m) 1:400@A1


0 2 4 6 8 10

PROPOSED LINEAR PARK
ARCHER STREET PARK &
CITISWICH STAGE 7

PROPOSED LANDSCAPE SECTIONS

JOB No. DWG No. ISSUE DRAWN BY CHECKED BY 22.054 4 S JB / HF AG

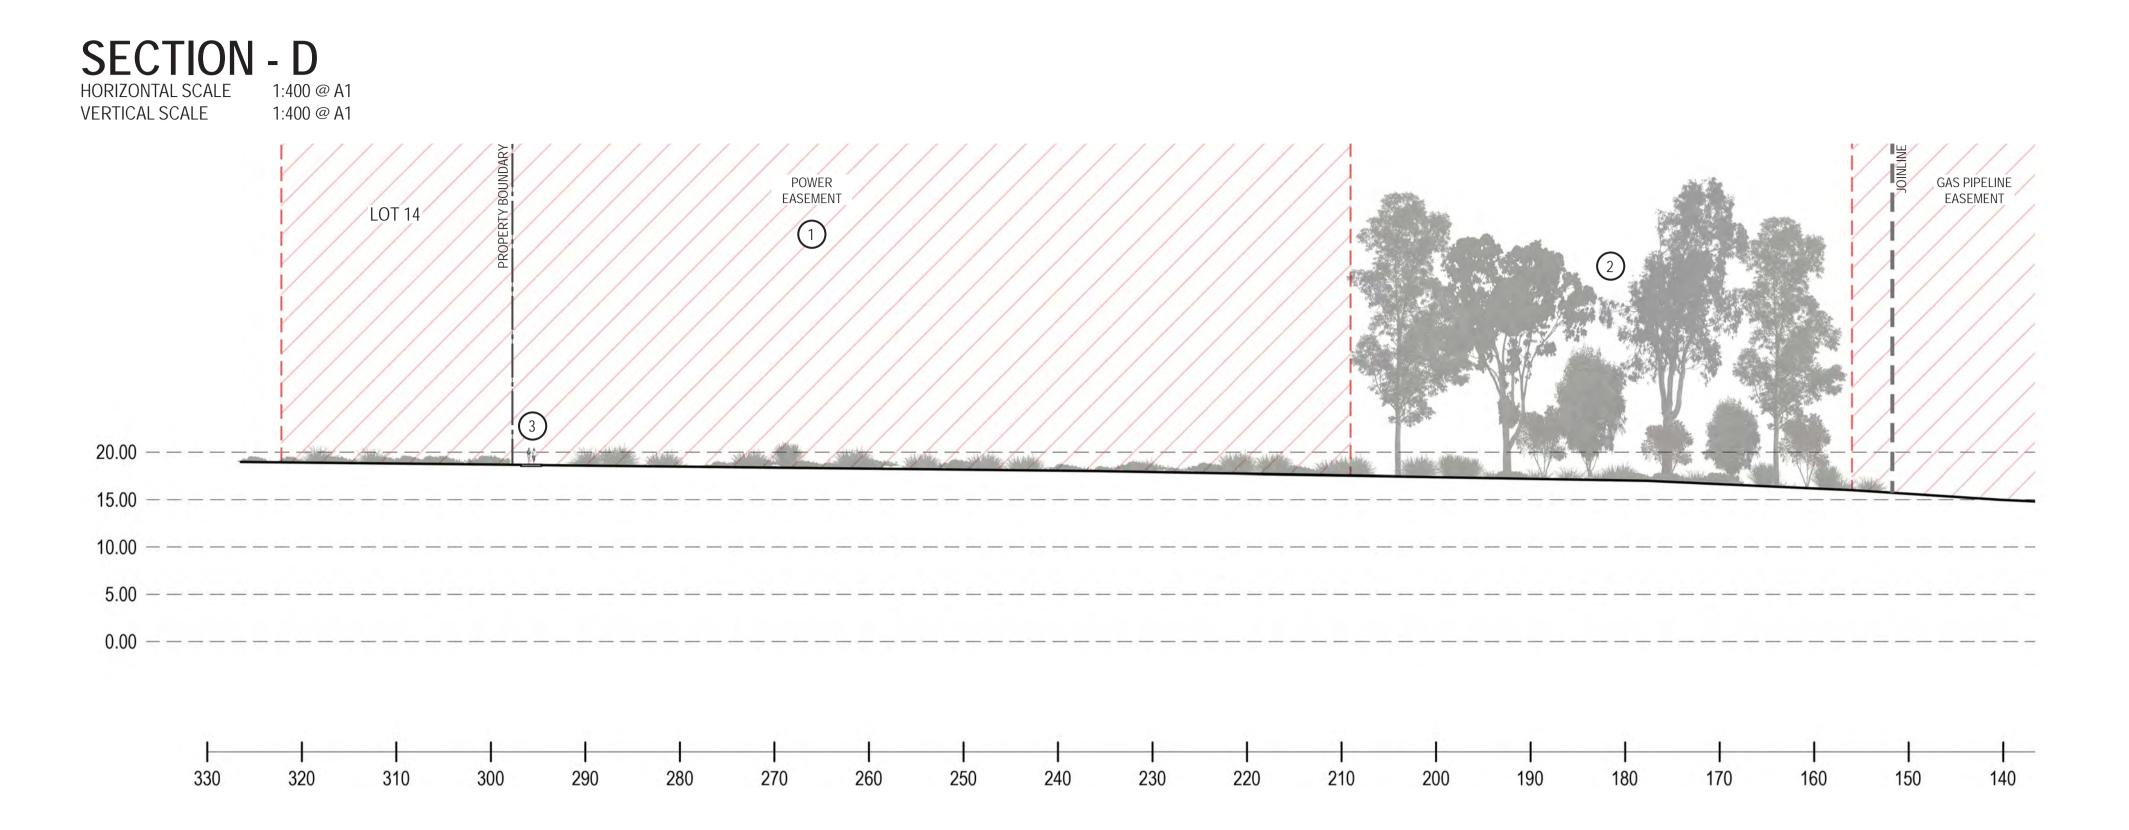

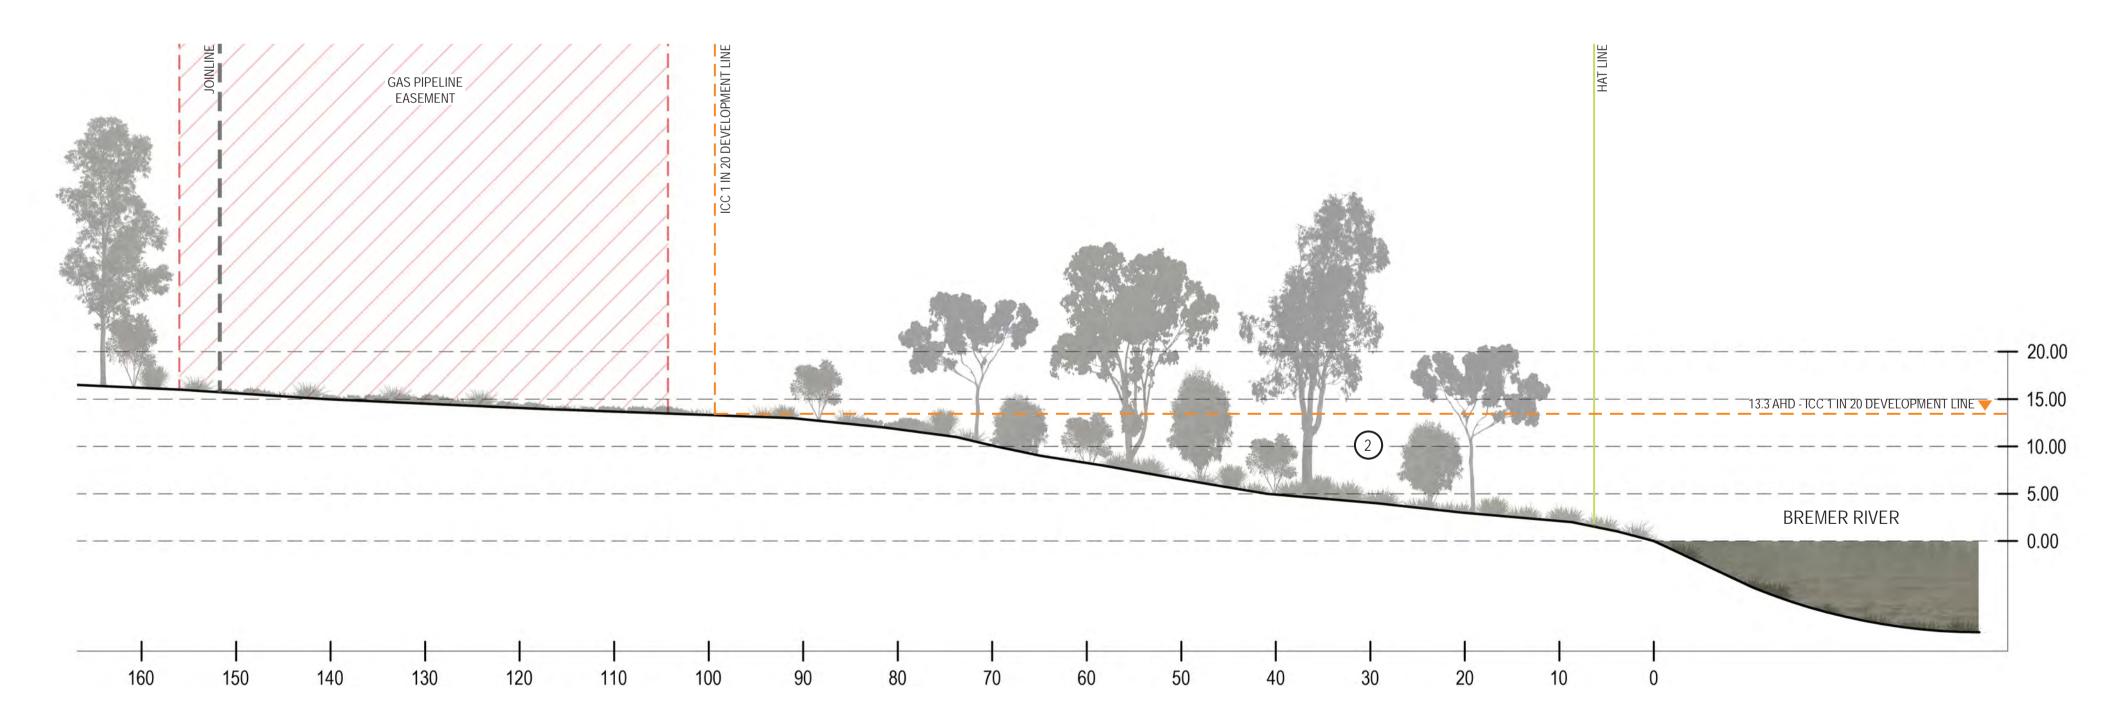



PO BOX 5220 MT GRAVATT EAST QLD 4122

T 07 3420 0006 M 0405 389 243 € andrew@agla.com.au

LEGEND:

1 POWER EASEMENT
No new plantings within easement to adhere to height restrictions. Keep clear for authority vehicle access.

2 EXISTING VEGETATION Indicative only

2200MM WIDE CONCRETE PATH
Provided to access locations of heritage interest and
connect to footpaths. Note some limitations due to
terrain and lack of surveillance. Exact alignment to be
confirmed on site

HAT LINE AT RL1.52 AHD

--- ICC '1 IN 20 DEVELOPMENT LINE' AT RL 13.3 AHD

S 03/05/24 AMENDMENTS AS REQUIRED R 19/04/24 AMENDMENTS AS REQUIRED Q 12/04/24 AMENDMENTS AS REQUIRED P 05/04/24 DRAFT FOR REVIEW

ISSUE DATE REA

THIS DRAWING HAS BEEN PREPARED WITH ALL CARE FROM BASE INFORMATION AVAILABLE AT THE TIME OF PREPARATION. ALL EXISTING AND RETAINED ELEMENTS ARE SHOWN INDICATIVELY ONLY. THE LOCATION OF THESE ELEMENTS ARE BASED FROM SURVEY INFORMATION. ALL PLANS AND DETAILS ARE TO BE READ IN CONJUNCTION WITH ALL RELEVANT CONSULTANT'S DOCUMENTATION PACKAGES, INCLUDING (BUT NOT LIMITED TO) ARCHITECTURAL, CIVIL, STRUCTURAL, HYDRAULIC, ELECTRICAL, LIGHTING AND SIGNAGE DOCUMENTATION. ALL ABOVE AND BELOW GROUND SERVICE LOCATIONS ARE SHOWN INDICATIVELY. REFER TO THE RELEVANT ENGINEERS DRAWINGS AS REQUIRED. ALL DIMENSIONS ARE TO BE VERIFIED ON SITE.


GRAPHIC SCALE (m) 1:400@A1


0 2 4 6 8 10

PROPOSED LINEAR PARK ARCHER STREET PARK & CITISWICH STAGE 7

PROPOSED LANDSCAPE SECTIONS

JOB No. DWG No. ISSUE DRAWN BY CHECKED BY 22.054 5 S JB / HF AG

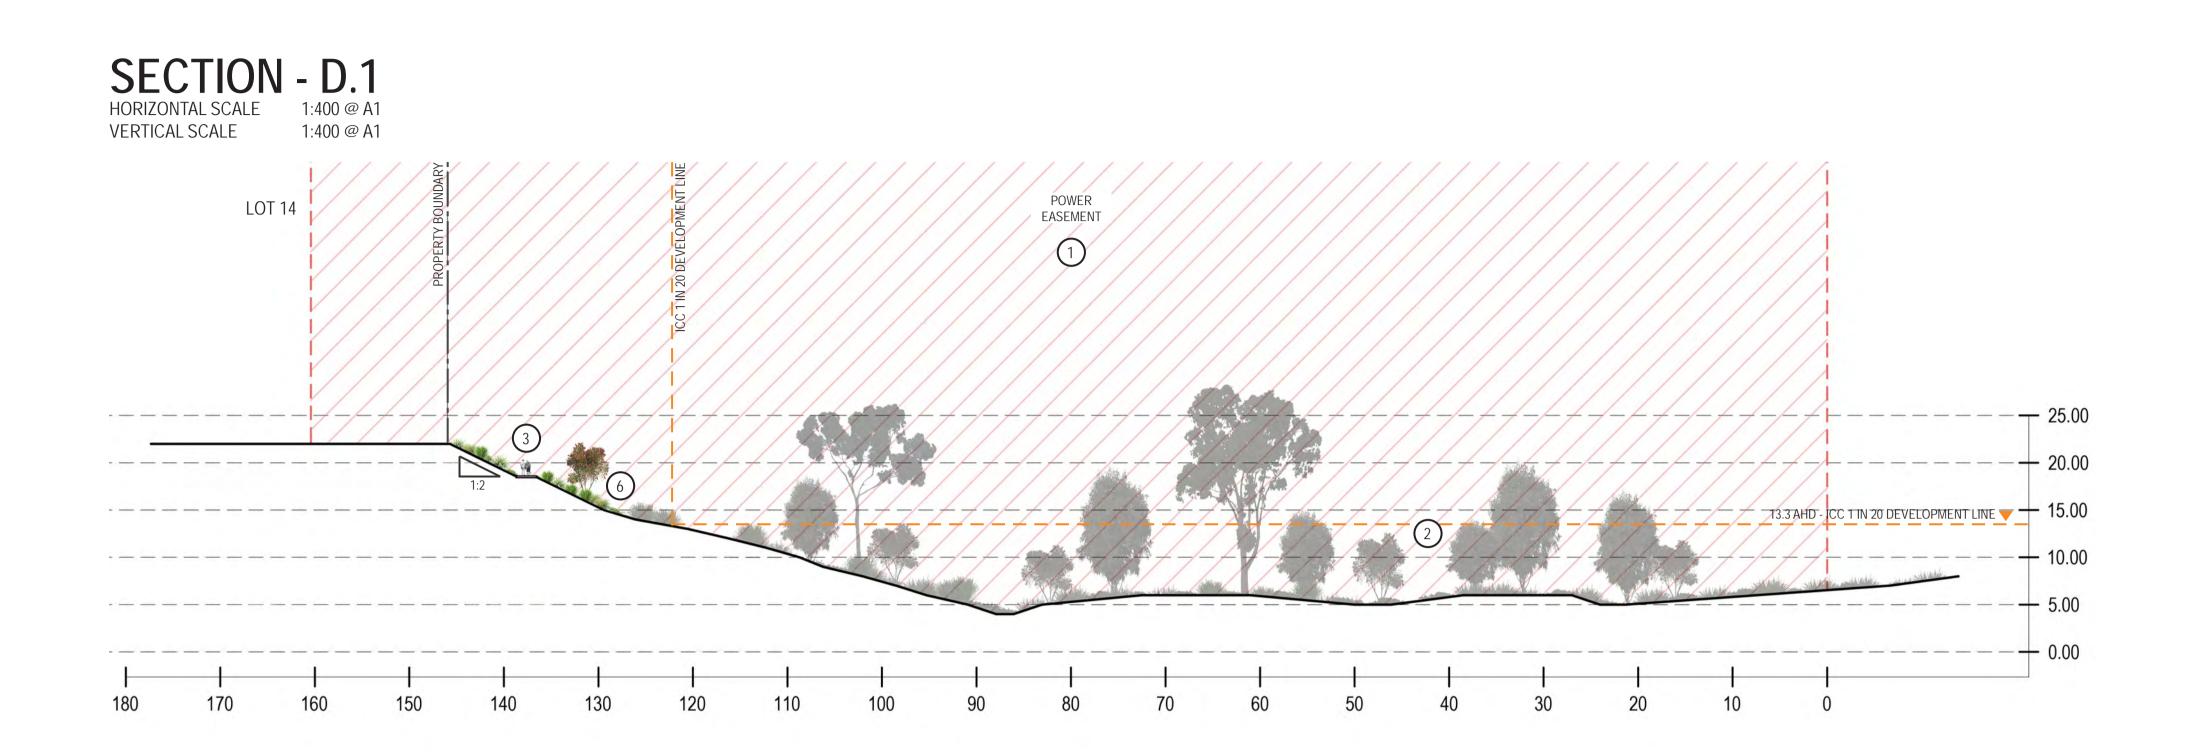

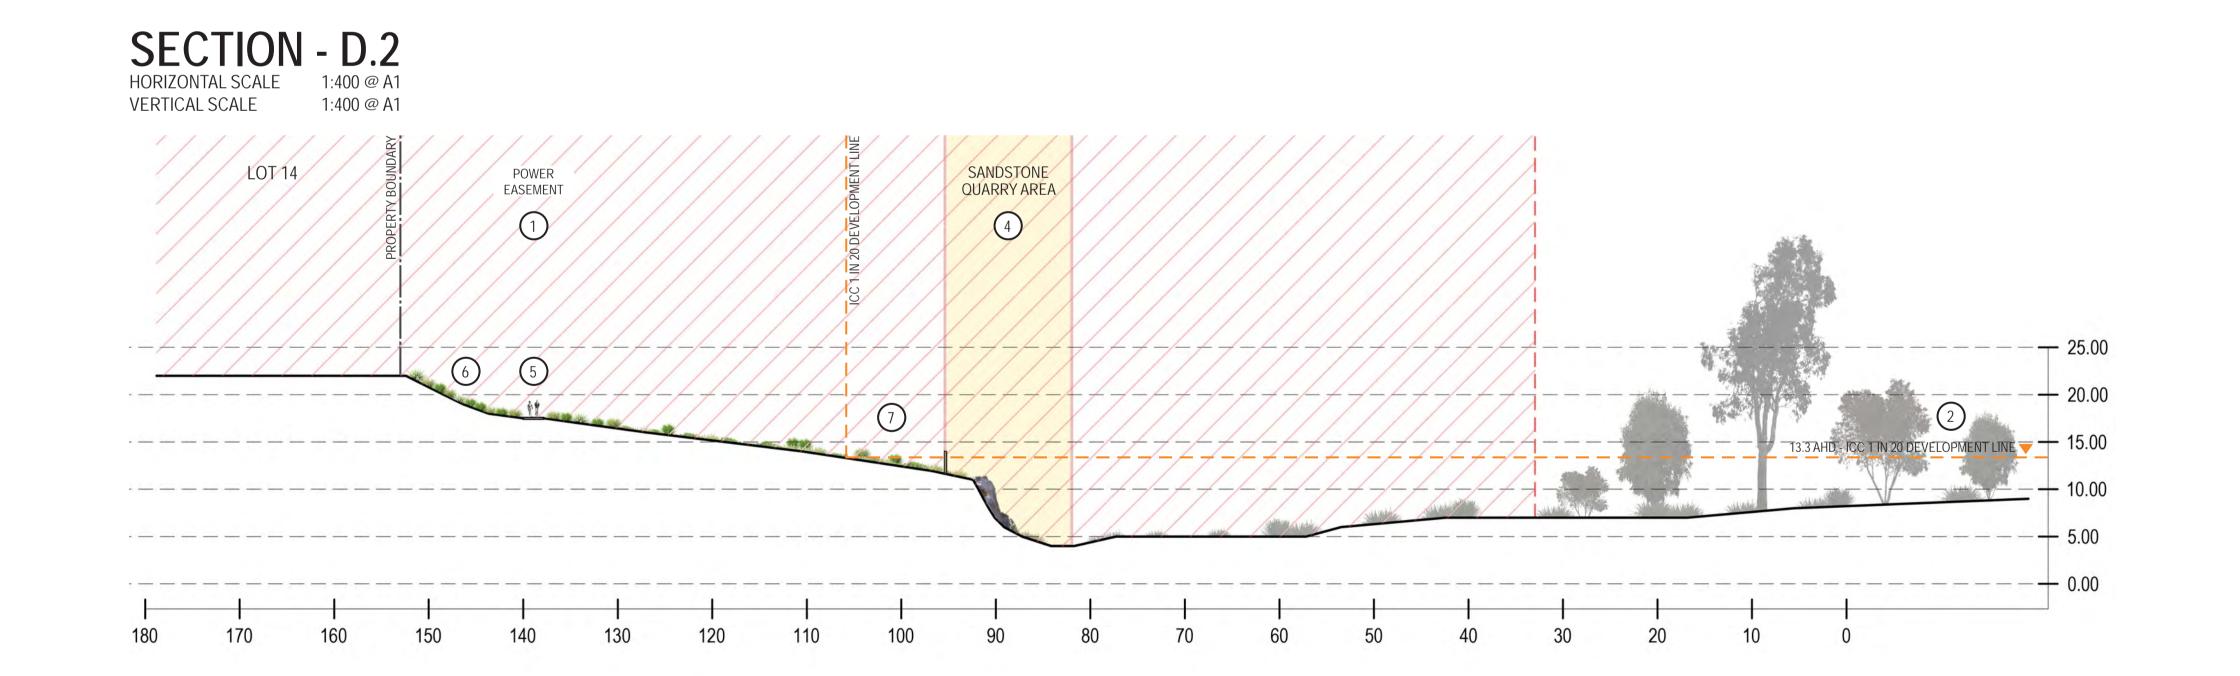



PO BOX 5220 MT GRAVATT EAST QLD 4122

T 07 3420 0006 M 0405 389 243 € andrew@agla.com.au

LEGEND:

- 1 POWER EASEMENT
  No new plantings within easement to adhere to height restrictions. Keep clear for authority vehicle access.
- 2 EXISTING VEGETATION Indicative only
- 2200MM WIDE CONCRETE PATH
  Provided to access locations of heritage interest and
  connect to footpaths. Note some limitations due to
  terrain and lack of surveillance. Exact alignment to be
  confirmed on site
- 4 HERITAGE SITE SOUTHERN QUARRY AREA
- PROPOSED LOOKOUT AREA
  Provide access and lookout area to southern quarry
  area. Install interpretive signages and facilities in
  accordance with Cultural Heritage Management Plan
- PROPOSED PARK REVEGETATION
  Species to be in accordance with Ipswich City Council standards, to future detail. Refer Engineering drawings for proposed earthworks.
- FENCING AND EROSION CONTROL MEASURES
  Fencing to be installed adjacent to the top of quarry to
  ensure pedestrian safety. Erosion control measures
  to be implemented through vegetation management
  on the slope to prevent soil erosion. Ensure adequate
  clearance of vegetation to prevent the roots from
  damaging the face of quarry.

--- ICC '1 IN 20 DEVELOPMENT LINE' AT RL 13.3 AHD

S 03/05/24 AMENDMENTS AS REQUIRED R 19/04/24 AMENDMENTS AS REQUIRED Q 12/04/24 AMENDMENTS AS REQUIRED P 05/04/24 DRAFT FOR REVIEW

ISSUE DATE REAS

THIS DRAWING HAS BEEN PREPARED WITH ALL CARE FROM BASE INFORMATION AVAILABLE AT THE TIME OF PREPARATION. ALL EXISTING AND RETAINED ELEMENTS ARE SHOWN INDICATIVELY ONLY. THE LOCATION OF THESE ELEMENTS ARE BASED FROM SURVEY INFORMATION. ALL PLANS AND DETAILS ARE TO BE READ IN CONJUNCTION WITH ALL RELEVANT CONSULTANT'S DOCUMENTATION PACKAGES, INCLUDING (BUT NOT LIMITED TO) ARCHITECTURAL, CIVIL, STRUCTURAL, HYDRAULIC, ELECTRICAL, LIGHTING AND SIGNAGE DOCUMENTATION. ALL ABOVE AND BELOW GROUND SERVICE LOCATIONS ARE SHOWN INDICATIVELY. REFER TO THE RELEVANT ENGINEERS DRAWINGS AS REQUIRED. ALL DIMENSIONS ARE TO BE VERIFIED ON SITE


GRAPHIC SCALE (m) 1:400@A1



PROPOSED LINEAR PARK ARCHER STREET PARK & CITISWICH STAGE 7

PROPOSED LANDSCAPE SECTIONS

JOB No. DWG No. ISSUE DRAWN BY CHECKED BY 22.054 6 S JB / HF AG

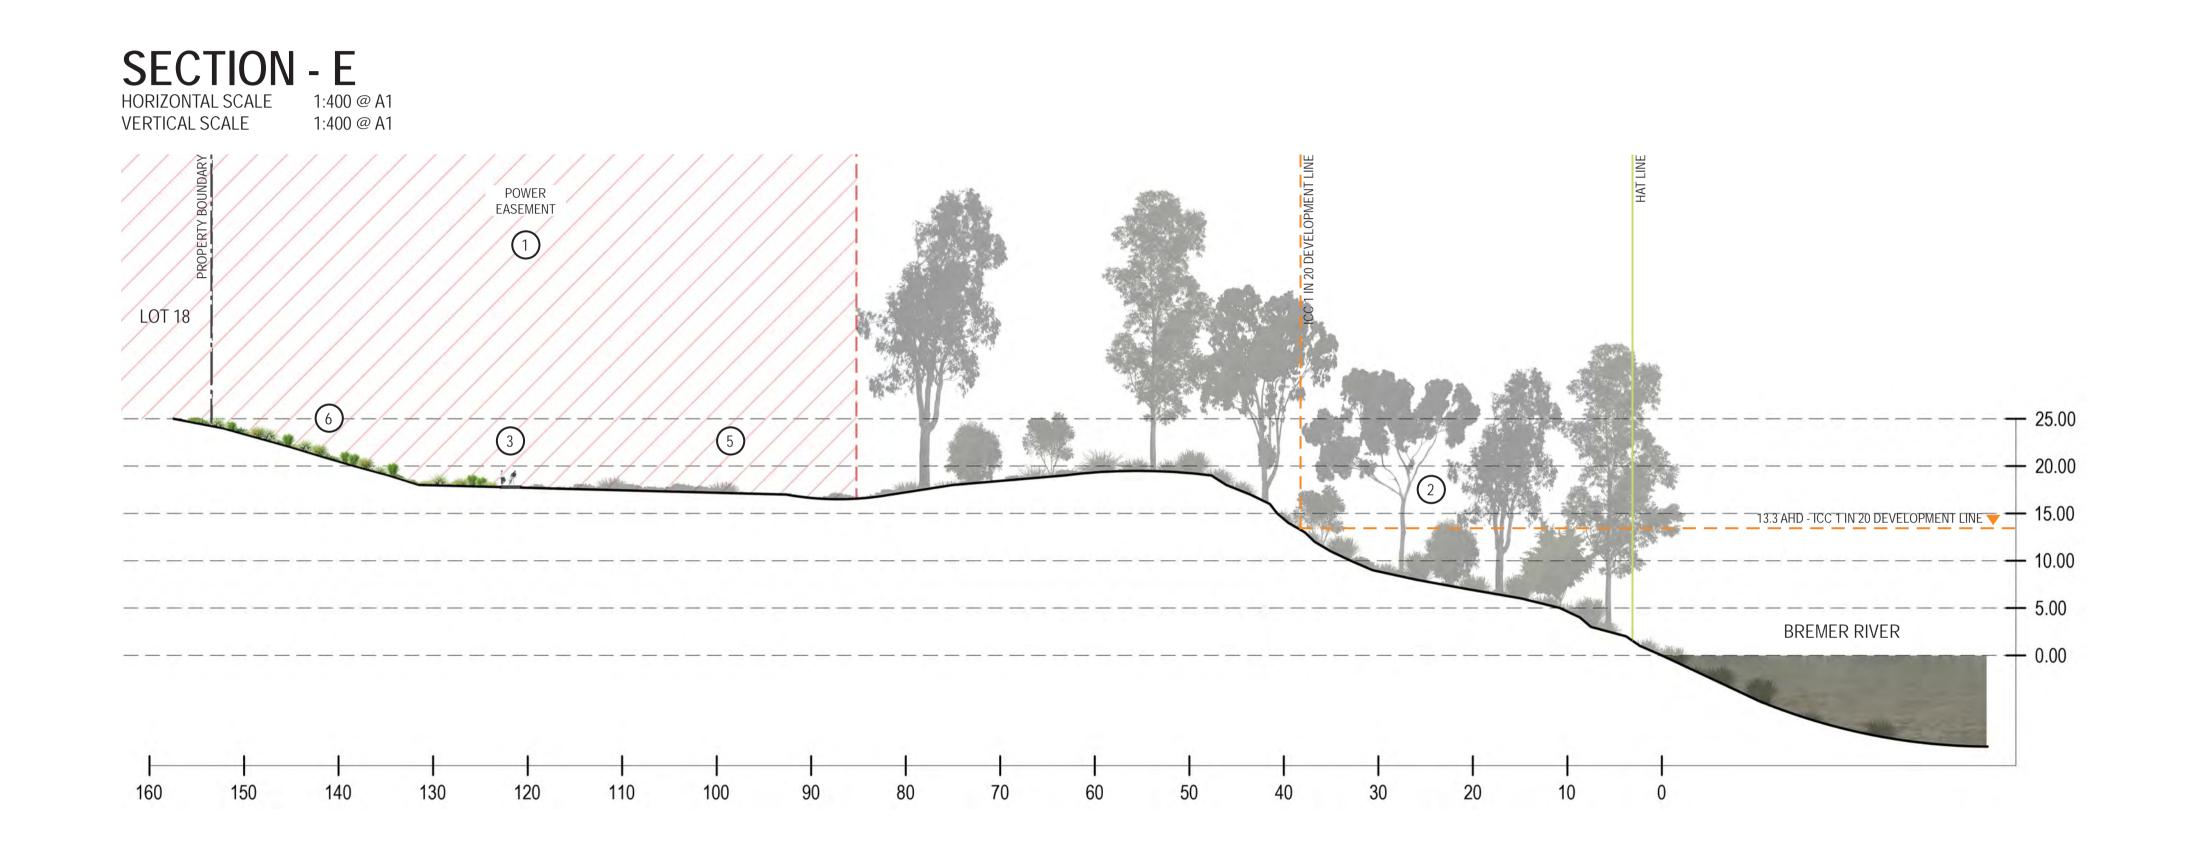



PO BOX 5220 MT GRAVATT EAST QLD 4122

T 07 3420 0006 M 0405 389 243 € andrew@agla.com.au

LEGEND:

- 1 POWER EASEMENT
  No new plantings within easement to adhere to height restrictions. Keep clear for authority vehicle access.
- 2 EXISTING VEGETATION Indicative only
- 3 2200MM WIDE CONCRETE PATH
  Provided to access locations of heritage interest and
  connect to footpaths. Note some limitations due to
  terrain and lack of surveillance. Exact alignment to be
  confirmed on site
- HERITAGE SITE WESTFALEN NO 2 LOADING FACILITIES
  Interpretive signage and safety restrictions to be installed
- 5 PROPOSED PARK REVEGETATION
  Species to be in accordance with Ipswich City Council standards, to future detail. Refer Engineering drawings for proposed earthworks.

HAT LINE AT RL1.52 AHD

--- ICC '1 IN 20 DEVELOPMENT LINE' AT RL 13.3 AHD

S 03/05/24 AMENDMENTS AS REQUIRED R 19/04/24 AMENDMENTS AS REQUIRED Q 12/04/24 AMENDMENTS AS REQUIRED P 05/04/24 DRAFT FOR REVIEW

ISSUE DATE REASON

THIS DRAWING HAS BEEN PREPARED WITH ALL CARE FROM BASE INFORMATION AVAILABLE AT THE TIME OF PREPARATION. ALL EXISTING AND RETAINED ELEMENTS ARE SHOWN INDICATIVELY ONLY. THE LOCATION OF THESE ELEMENTS ARE BASED FROM SURVEY INFORMATION. ALL PLANS AND DETAILS ARE TO BE READ IN CONJUNCTION WITH ALL RELEVANT CONSULTANT'S DOCUMENTATION PACKAGES, INCLUDING (BUT NOT LIMITED TO) ARCHITECTURAL, CIVIL, STRUCTURAL, HYDRAULIC, ELECTRICAL, LIGHTING AND SIGNAGE DOCUMENTATION. ALL ABOVE AND BELOW GROUND SERVICE LOCATIONS ARE SHOWN INDICATIVELY, REFER TO THE RELEVANT ENGINEERS DRAWINGS AS REQUIRED. ALL DIMENSIONS ARE TO BE VERIFIED ON SITE.


GRAPHIC SCALE (m) 1:400@A1


0 2 4 6 8 10

PROPOSED LINEAR PARK ARCHER STREET PARK & CITISWICH STAGE 7

PROPOSED LANDSCAPE SECTIONS

JOB No. DWG No. ISSUE DRAWN BY CHECKED BY 22.054 6 S JB / HF AG

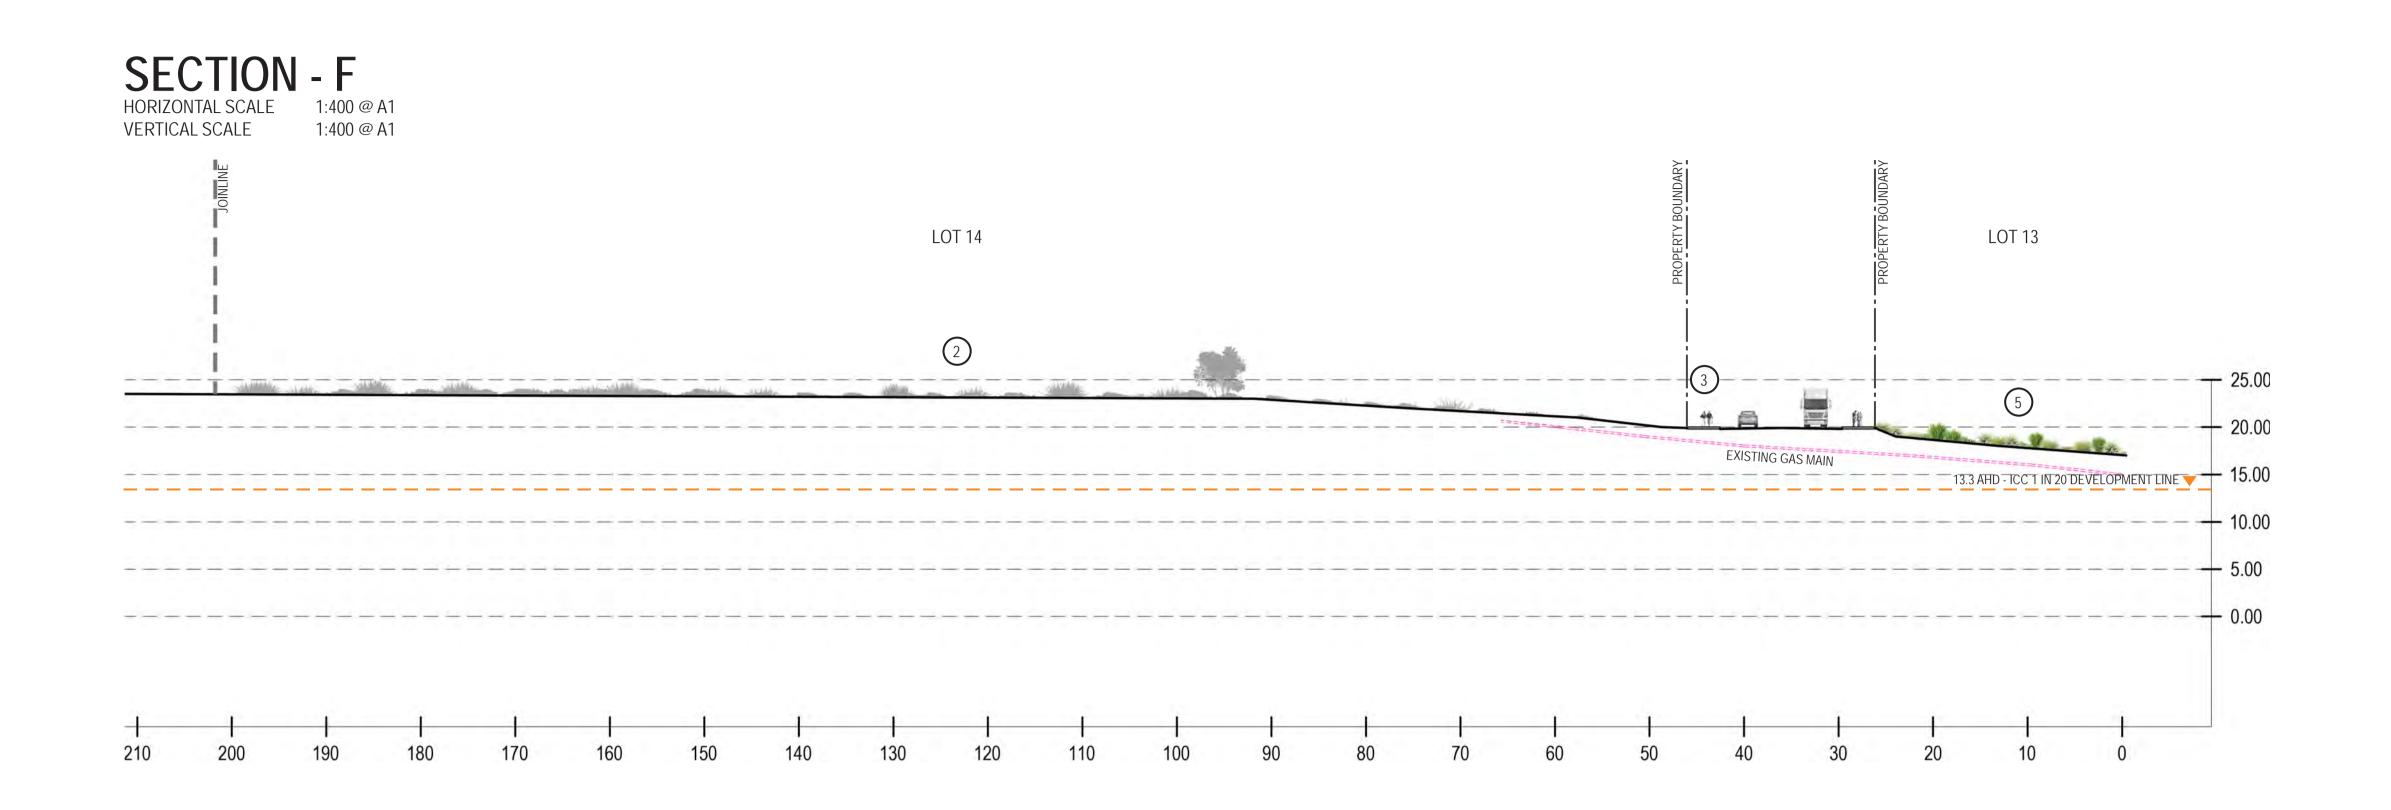

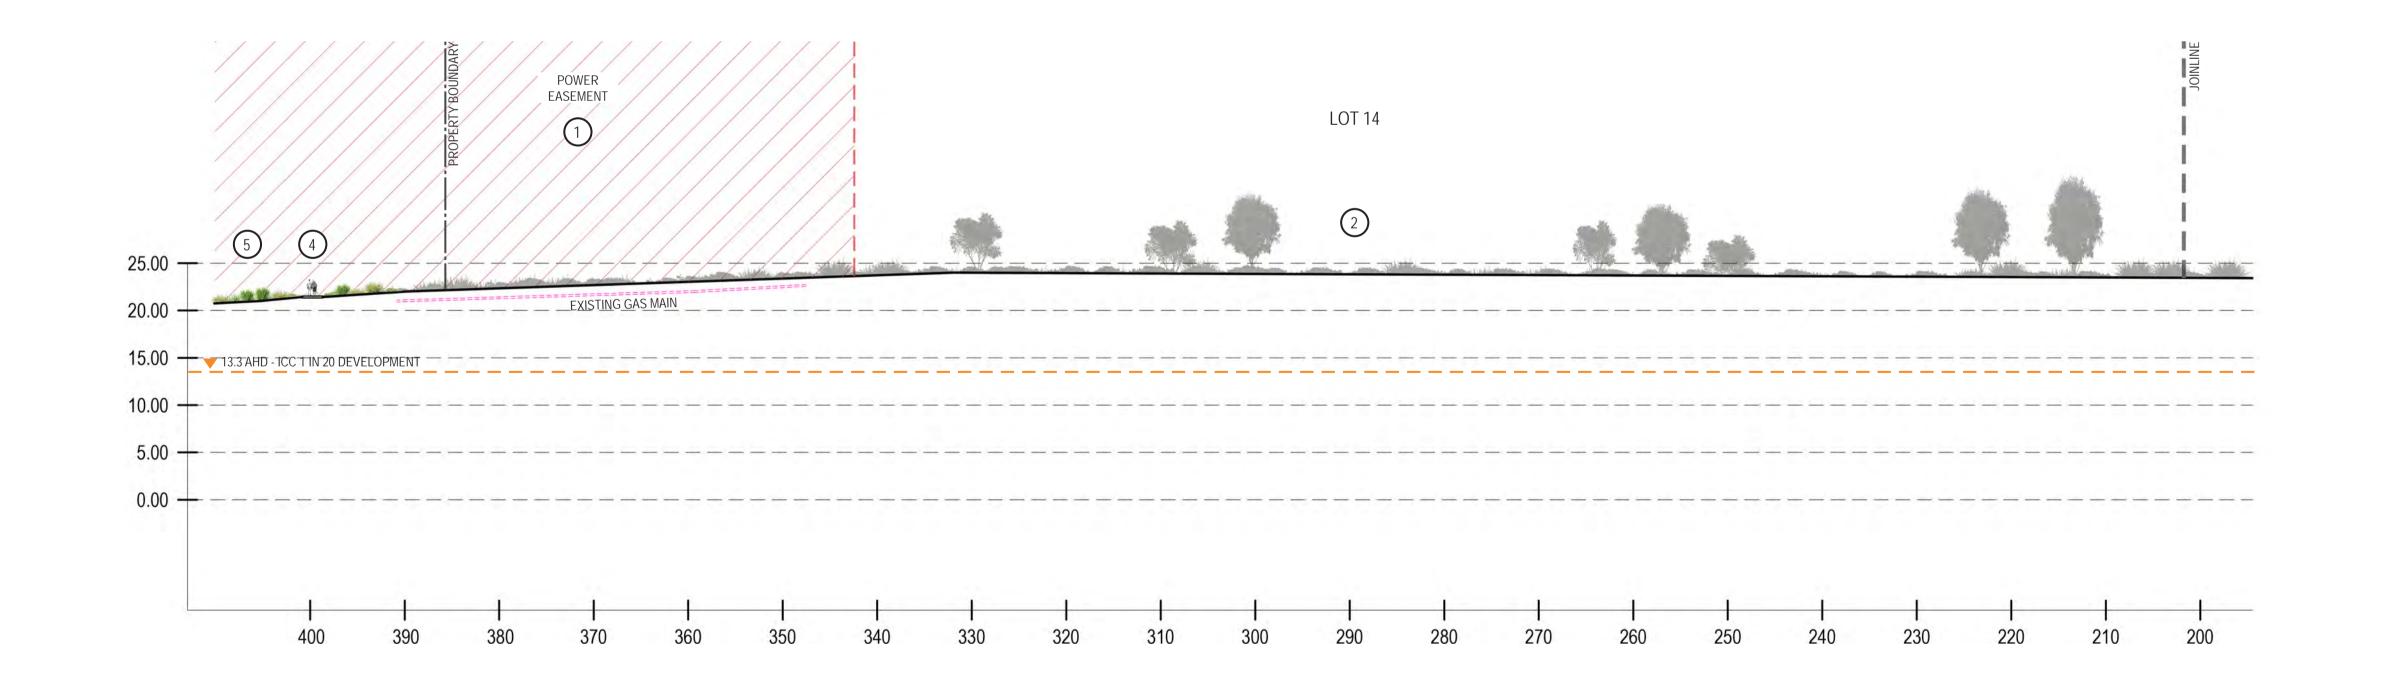



PO BOX 5220 MT GRAVATT EAST QLD 4122

T 07 3420 0006 M 0405 389 243 € andrew@agla.com.au

LEGEND:

1 POWER EASEMENT
No new plantings within easement to adhere to height restrictions. Keep clear for authority vehicle access.

2 EXISTING VEGETATION Indicative only

2500MM WIDE DUAL USE PATH Refer Engineering plans for overall pathway network

2200MM WIDE CONCRETE PATH
Provided to access locations of heritage interest and
connect to footpaths. Note some limitations due to
terrain and lack of surveillance. Exact alignment to be
confirmed on site

PROPOSED PARK REVEGETATION
Species to be in accordance with Ipswich City Council standards, to future detail. Refer Engineering drawings for proposed earthworks.

— — — ICC '1 IN 20 DEVELOPMENT LINE' AT RL 13.3 AHD

EXISTING GAS MAIN BEHIND (APPROX. 900MM COVER). VERIFY LOCATION AND LEVELS PRIOR TO COMMENCEMENT OF WORKS

S 03/05/24 AMENDMENTS AS REQUIRED R 19/04/24 AMENDMENTS AS REQUIRED Q 12/04/24 AMENDMENTS AS REQUIRED P 05/04/24 DRAFT FOR REVIEW

ISSUE DATE REA

THIS DRAWING HAS BEEN PREPARED WITH ALL CARE FROM BASE INFORMATION AVAILABLE AT THE TIME OF PREPARATION. ALL EXISTING AND RETAINED ELEMENTS ARE SHOWN INDICATIVELY ONLY. THE LOCATION OF THESE ELEMENTS ARE BASED FROM SURVEY INFORMATION. ALL PLANS AND DETAILS ARE TO BE READ IN CONJUNCTION WITH ALL RELEVANT CONSULTANT'S DOCUMENTATION PACKAGES, INCLUDING (BUT NOT LIMITED TO) ARCHITECTURAL, CIVIL, STRUCTURAL, HYDRAULIC, ELECTRICAL, LIGHTING AND SIGNAGE DOCUMENTATION. ALL ABOVE AND BELOW GROUND SERVICE LOCATIONS ARE SHOWN INDICATIVELY. REFER TO THE RELEVANT ENGINEERS DRAWINGS AS REQUIRED. ALL DIMENSIONS ARE TO BE VERIFIED ON SITE.

GRAPHIC SCALE (m) 1:400@A1

0 2 4 6 8 10

PROPOSED LINEAR PARK ARCHER STREET PARK & CITISWICH STAGE 7

PROPOSED LANDSCAPE SECTIONS

JOB No. DWG No. ISSUE DRAWN BY CHECKED BY 22.054 6 S JB / HF AG